




| DOOR SCHEDULE | | | |
|---------------|-----------------------------------------------------------------|--|--|
| MARK NO. | DESCRIPTION | | |
| A | 3'-0"W X 7'-0"H PERSONNEL DOOR (SWING AS SHOWN ON PLAN VIEW) | | |

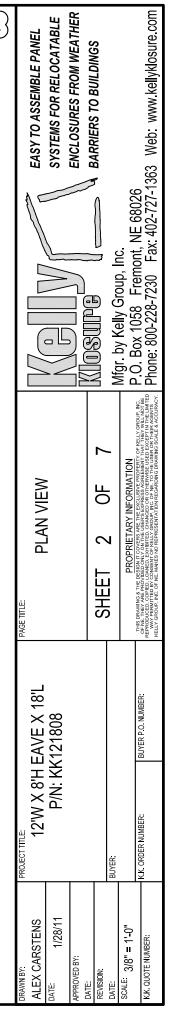


PLAN VIEW

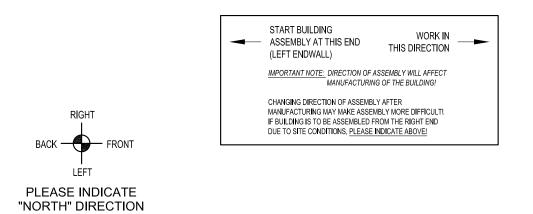


NOT FOR CONSTRUCTION

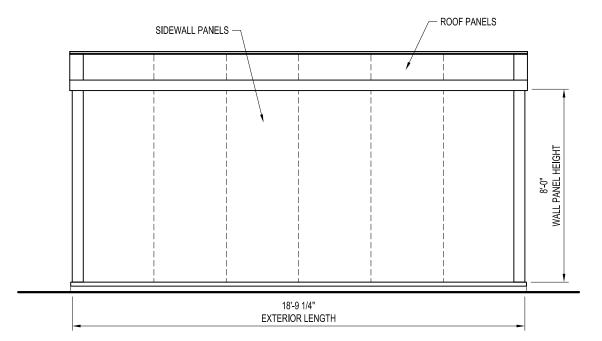


LEFT ELEVATION

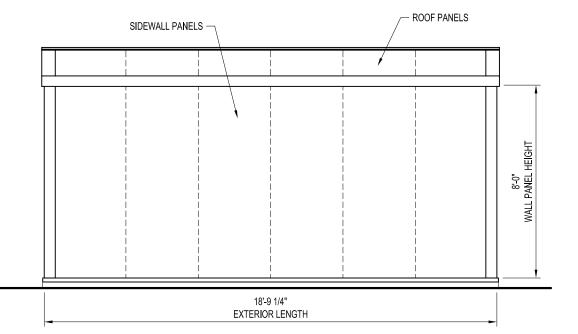

RIGHT ELEVATION

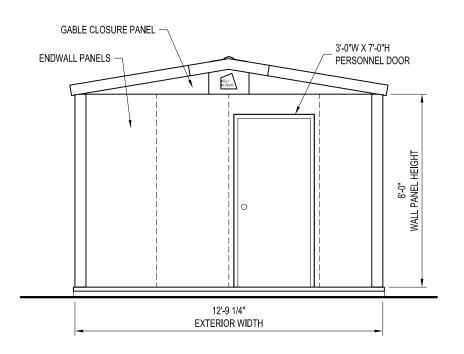


FRONT ELEVATION

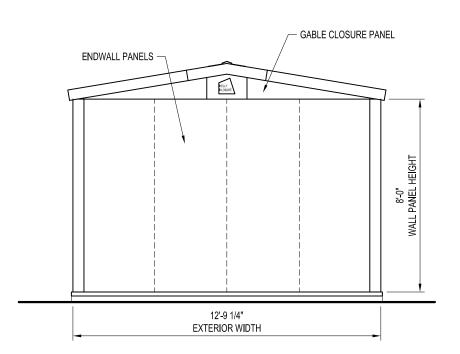


BACK ELEVATION

| EASY TO ASSEMBLE PANEL | SYSTEMS FOR RELOCATABLE | ENCLOSURES FROM WEATHER | I I I I I I I I I I I I I I I I I I I | | Mfar by Kolly Crain lac | | | Phone: 800-228-7230 |
|---------------------------------------|-------------------------|-------------------------|---------------------------------------|--------------|-------------------------|-------------------------|-------------------------------------------------------------------------------------------------------------------------------------------------------------------------|-----------------------------------------------------------------------------------------------------------------------------------------------------------------------------------------------------------------------------------------------------------------------------|
| PAGE TITLE: FI EVATIONS | | | | SHEFT 3 OF 7 | | PROPRIETARY INFORMATION | THIS DRAWING & THE DESIGN IT COVERS ARE THE EXCLUSIVE PROPERTY OF KELLY GROUP, INC. OF NE. THEY ARE PROVIDED ONLY ON THE USER'S EXPRESS AGREEMENT THAT THEY WILL NOT BE | NENTODICELE USANELLE JABRIELE JARRIELE JARRIELE DE TRANSLED DE LO THE RUSE TO COTEL. TO THE LIMI ELD WAY PERMITTED BY CONSENT OF RELLY GROUP, INC. OF NE. TO THE USER OR THEIR AGENTS KELLY GROUP, INC. OF NE. MAKES NO REPRESENTATION REGARDING DRAWING SCALLE & ACCURACY. |
| PROJECT TITLE: 12'W X 8'H EAVE X 18'L | P/N: KK121808 | | | | BUYER: | | K.K. ORDER NUMBER: BUYER P.O. NUMBER: | |
| DRAWN BY: ALEX CARSTENS | DATE: 1/28/11 | APPROVED BY: | DAIE: | REVISION: | DATE: | SCALE: 1/4" = 1'-0" | Ī | N.N. QUOTE NUMBER: |

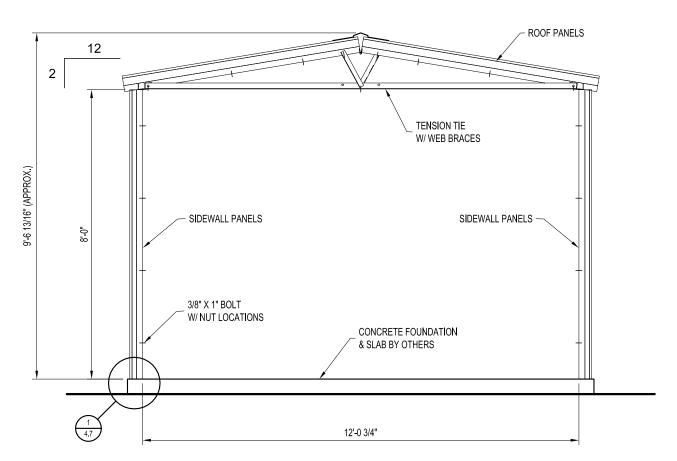

CROSS-SECTION (12'-0" WIDTH)

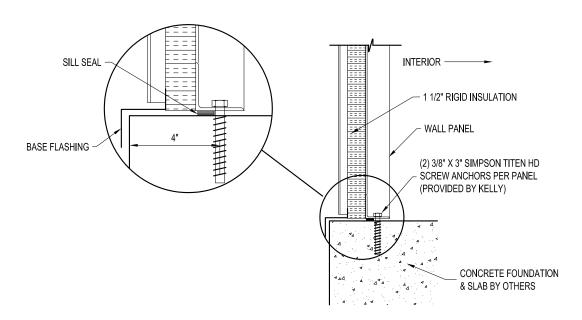

1 PANEL BASE SECTION 4.7 SCALE: 1 1/2" = 1'-0"

| EASY TO ASSEMBLE PANEL SYSTEMS FOR RELOCATABLE ENCLOSURES FROM WEATHER | | INTERPORTED OF THE PRINCES TO BOILDINGS | Mfor by Kolly Crain lac | I MIGI. DY NOILY GLOUP, ITIC. | |
|------------------------------------------------------------------------|-------|-----------------------------------------|-------------------------|-------------------------------|--------------------------------------------------------------------------------------------------------------------------------------------------------------------------------------------------------------------------------------------------------------------------------------------------------------------------------------------------------------------------------------------------------------------------|
| PAGE TITLE: CROSS-SECTION | | SHEET A OF 7 | - 5 | PROPRIETARY INFORMATION | THIS DRAWING A THE DESIGN IT OCKERS THE EXCLUSIVE PROPERTY OF SELLY GROUP, INC. OF HE THEY ARE PROVIDED ONLY ON THE USER'S EXPRESS AGREEMENT THAT THEY WILL NOT BE REPRODUCED. COPIED, LONDIND, EXHIBITED EXAMED OF OTHERWING USED EXCEPT IN THE MITTED WAY PREMITTED BY CONSIST OF FILLY GROUP, INC. OF NOT, OTHER USER OF THEIR AGENTS WAY PREMITTED BY CONSIST OF PERILY GROUP, INC. OF NOT. OTHER GRACIALS AGCURACY. |
| рвојестти.е. 12'W X 8'H EAVE X 18'L P/N: KK121808 | | | BUYER: | | K.K. ORDER NUMBER: BUYER P.O. NUMBER: |
| DRAWN BY: ALEX CARSTENS DATE: 1/28/11 APPROVED BY: | DATE: | REVISION: | DATE: | SCALE: 3/8" = 1'-0" | |

BUILDING STRUCTURE

BUILDING STRUCTURAL DESIGN CRITERIA

BUILDING CODE:

ROOF LOAD: 40 PSF (GROUND SNOW LOAD)

SNOW DRIFT LOAD: NONE

WIND LOAD: 100 MPH (3 SECOND GUST)

SEISMIC: DESIGN CATEGORY "C", SOIL SITE CLASS "D"

OCCUPANCY CATEGORY:

- THIS BUILDING HAS BEEN DESIGNED IN ACCORDANCE WITH THE BUILDING CODE AND BASIC STRUCTURAL DESIGN DATA LISTED ABOVE. THE BUILDING HAS BEEN DESIGNED AND ENGINEERED FROM A STRUCTURAL ASPECT ONLY. OTHER CODE COMPLIANCE ISSUES SUCH AS OCCUPANCY, EGRESS, HVAC, ELECTRICAL, MECHANICAL, FIRE SAFETY ETC. IS THE RESPONSIBILITY OF THE END USER OR ITS REPRESENTATIVES. MATERIAL SPECIFICATIONS ARE AVAILABLE UPON REQUEST.
- ANY REQUIRED "MAJOR PENETRATIONS" THROUGH THE WALLS OR ROOF OF THE BUILDING SHOULD BE NOTED AND LOCATED BEFORE RELEASE FOR MANUFACTURING IS GIVEN. THIS WILL ALLOW KELLY TO MODIFY FRAMING AS NECESSARY, FIELD CUTTING OF ANY STEEL FRAMING MEMBERS IS NOT RECOMMENDED AND WILL VOID THE STRUCTURAL DESIGN CRITERIA AND ANY WARRANTIES. "MAJOR PENETRATIONS" ARE ITEMS LIKE HVAC DUCTS AND LARGE PIPES OR CONDUITS.
- IF PERMITS ARE TO BE PULLED FOR THIS PROJECT, KELLY KLOSURE RECOMMENDS THAT THIS BE DONE BEFORE BUILDING IS RELEASED FOR MANUFACTURING. ANY INSPECTIONS REQUIRED FOR PERMITS ARE THE RESPONSIBILITY OF THE END USER OR ITS REPRESENTATIVES.


IMPORTANT NOTE: ANY AND ALL CHANGES, MODIFICATIONS OR RETROFITS REQUIRED DUE TO PERMITS BEING PULLED AFTER THE BUILDING IS MANUFACTURED ARE NOT KELLY'S RESPONSIBILITY.

FOUNDATIONS

- RECOMMENDED FOUNDATION SIZE IS GIVEN ON THE FOUNDATION PLAN VIEW PAGE OF THIS SET.
 - OUTSIDE DIMENSIONS AS SHOWN ARE REQUIRED TO ACCEPT BUILDING BASE FLASHING AS SUPPLIED. A TOLERANCE OF + OR - 1/4" IS ACCEPTABLE. THE SLAB SHOULD BE LEVEL AROUND PERIMETER OF FOUNDATION WITH A TOLERANCE OF + OR - 1/4". ANY VARIANCE COULD CREATE A LEAKAGE PROBLEM AT BASE OF BUILDING.
 - IF THE BUILDING IS TO BE PLACED ON A LARGER FOUNDATION THAN SHOWN, SPECIAL BASE FLASHING CAN BE SUPPLIED UPON REQUEST.
 - USERS ARE TO ESTABLISH SIZE AND REINFORCEMENT REQUIREMENTS FOR FOUNDATIONS TO ACCOMMODATE SITE SOIL CONDITIONS AND LOCAL FROST DEPTH.
 - BUILDING ANCHOR BOLT REACTIONS ARE AVAILABLE UPON REQUEST.

ANCHOR BOLTS

- PRESETTING OF ANCHOR BOLTS IS NOT REQUIRED. ANCHOR BOLTS WILL BE INSTALLED AS THE BUILDING IS ERECTED. KELLY RECOMMENDS THE SIMPSON TITEN HD SCREW ANCHOR AS SHOWN ON THE BUILDING BASE SECTION ON THE CROSS-SECTION PAGE.
- CONCRETE ANCHORS WILL BE SUPPLIED WITH THE BUILDING SHIPMENT.

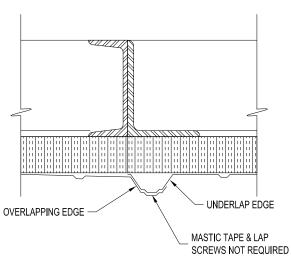

OVERLAP DETAIL

PANEL COMPONENTS AND FINISHES (SEE PANEL COMPONENTS ISOMETRIC)

- PANEL FRAMES & STRUCTURAL STEEL COMPONENTS
 - ONE COAT, CORROSION RESISTANT, WATER REDUCIBLE, ACRYLIC ALKYD EMULSION PRIMER

EXTERIOR STEEL SIDING AND ROOFING

- 29 GA. 3/4" RIBBED "IMPERIAL RIB", DOES NOT REQUIRE SEAL TAPE OR STITCH SCREWS AT OVERLAPS
- SIDING AND ROOFING TO BE GALVALUME COATED WITH PRIMER AND SILICONE MODIFIED POLYESTER
- FACTORY INSTALLED INSULATION
 - INSULATION TO BE RIGID, CLOSED CELL, POLYISOCYANURATE WITH FOIL FACING
 - WALLS: 1.1/2" THICK (R-11)
 - ROOF: 2.1/2" THICK (R-19) c)
- FACTORY INSTALLED STEEL INSULATION LINER
 - 28 GA. G-90 GALVANIZED STEEL
 - INSTALLED IN WALLS ONLY

PERSONNEL AND EQUIPMENT DOORS

3'W X 7'H PERSONNEL DOOR FACTORY INSTALLED IN A 3'-9" WIDE WALL PANEL,

TYPE "A" SHOWN ON PLAN VIEW

DOOR FRAME: 16 GA, STEEL, PRIMED AND FINISH PAINTED

DOOR LEAF: 18 GA. STEEL, HONEYCOMB CORE, PRIMED AND FINISH PAINTED


STANDARD LOCKSET, S.PARKER B9160 SERIES, STAINLESS STEEL *ENTRY LOCK:


HINGES: (3) 4,5" BALL BEARING, STANLEY FBB179, US26D FINISH

STANDARD, S.PARKER 954, ALUMINUM FINISH *CLOSER:

STANDARD, MD DCV134, ALUMINUM FINISH DOOR SWEEP:

WEATHER STRIPPING: NONE

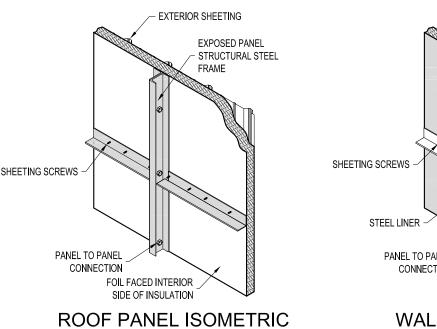


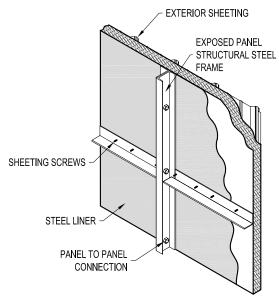

WALL PANEL ISOMETRIC

EASY TO ASSEMBLE PANEL
SYSTEMS FOR RELOCATABLE
ENCLOSURES FROM WEATHER
BARRIERS TO BUILDINGS www.kellyklosure. Web NE 68 Group, Inc. by Kelly PANEL ISOMETRIC **BUILDING NOTES** Я 9 SHEET ∞ర 12'W X 8'H EAVE X 18'L P/N: KK121808 1/28/11 2 N

NOT FOR CONSTRUCTION

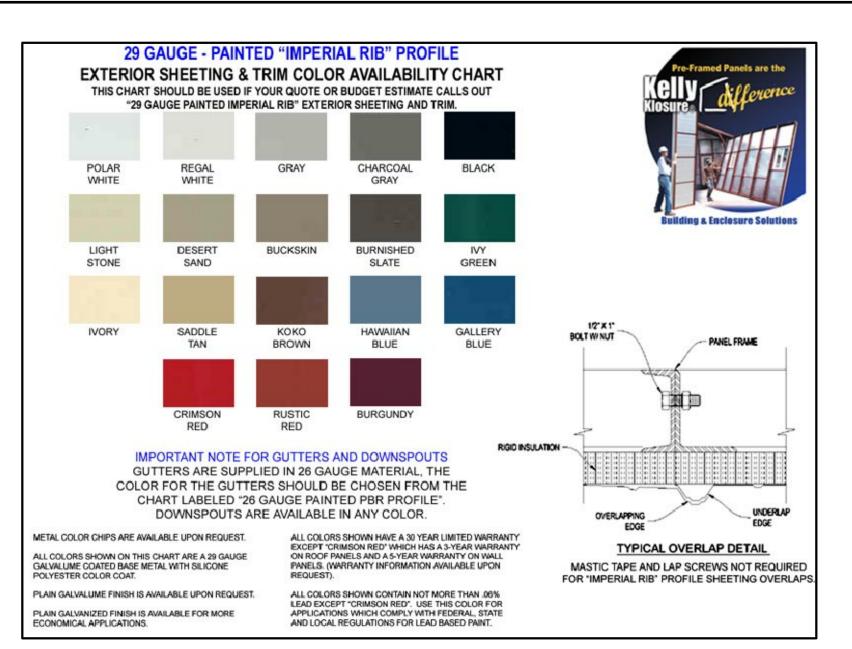

INSTRUCTIONS FOR OPTIONAL DOORS & ACCESSORY LOCATIONS

EQUIPMENT DOOR PLACEMENT & SIZE RESTRICTIONS:

THE OPTIONAL EQUIPMENT DOOR MUST BE PLACED IN ONE OF THE END WALLS WITH AT LEAST ONE FULL PANEL OPEN ON BOTH SIDES. THE DOOR WILL NEED AT LEAST 2'-6" CLEAR ABOVE FOR THE MANUAL OR ELECTRIC OPERATOR.

3'-0"W PERSONNEL DOOR PLACEMENT RESTRICTIONS:

PERSONNEL DOORS WILL BE PLACED IN 3'-9" PANELS WITH A 2'-3" PANEL BESIDE THEM. THE DOORS CANNOT BE PLACED ON THE END PANEL OF ANY WALL.

5'-8"W DOUBLE DOOR PLACEMENT RESTRICTIONS:

DOUBLE DOORS WILL BE PLACED IN 6'-0" PANELS. THE DOORS CANNOT BE PLACED ON THE END PANEL OF ANY WALL.

| COLOR SCHEDULE | | | | | |
|----------------------------------------------------------------------------------------------------|----------------------------------|--|--|--|--|
| CHOOSE COLORS ACCORDING TO CHARTS LOCATED AT: http://www.kellyklosure.com/resource CLICK ON: | | | | | |
| "29 GAUGE PAINTED IMPERIAL RIB PROFILE COLOR CHART | | | | | |
| ITEM | COLOR OR FINISH REQUESTED | | | | |
| ROOF SHEETING & RIDGE CAP | | | | | |
| WALL SHEETING & BASE FLASHING | | | | | |
| VERTICAL CORNER FLASHING | | | | | |
| EAVE & GABLE FLASHING | | | | | |
| PERS. & EQUIPMENT DOOR TRIM | | | | | |
| PERSONNEL DOORS | GRAY | | | | |
| INTERIOR LINER | GALVANIZED STEEL (WALLS ONLY) | | | | |
| EXPOSED INTERIOR STRUCTURAL STEEL | STANDARD RED PRIMER | | | | |

